
PROJECT SITE **LOCATION MAP**

CITY OF AUBURN, MAINE **AUBURN-LEWISTON AIRPORT**

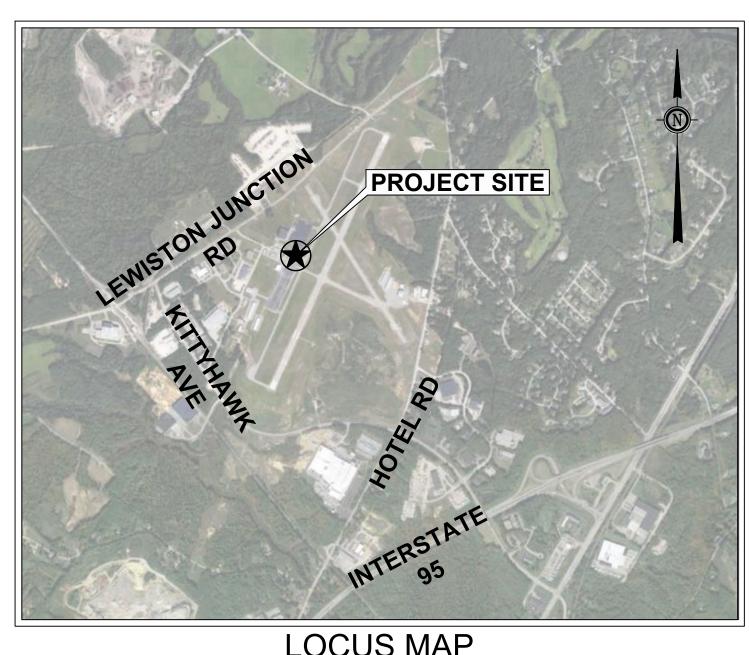

LOCUS MAP

RELOCATE FUEL TANK AND INSTALL SELF-SERVICE EQUIPMENT

BID NUMBER: LA 2024-001


JULY 2023

INDEX TO DRAWINGS					
DW	/G NO.	TITLE			
1	G1.1	TITLE SHEET			
2	G1.2	GENERAL PLAN			
3	3 S1.1 SAFETY AND PHASING PLAN AND DETAILS				
4	S2.1	SAFETY AND PHASING NOTES			
5	C1.1	SITE PLAN			
6	C2.1	CONSTRUCTION DETAILS			

DRAWING NO.

SHEET 1 OF 6

CITY OF AUBURN, MAINE ENGINEER'S STATEMENT REGARDING COMPLIANCE MAJOR ITEM QUANTITIES PREPARED BY **AUBURN-LEWISTON AIRPORT** THESE PLANS AND SPECIFICATIONS HAVE BEEN PREPARED TO THE QUANTITY DESCRIPTION Gale Associates, Inc BEST OF MY KNOWLEDGE AND BELIEF, IN ACCORDANCE WITH THE Engineers Architects Planners LIST OF CURRENT FAA ADVISORY CIRCULARS FOR AIP PROJECTS PROVIDED BY THE FAA IN A LETTER DATED NOVEMBER 17, 2022 6 Bedford Farms Dr., Suite 101 | Bedford, NH 03110 KNOWN DEVIATIONS FROM FAA STANDARDS WERE APPROVED BY FAA MR. JONATHAN LABONTE - CHAIRMAN, BOARD OF DIRECTORS Connecticut | Florida | Maine | Maryland IN LETTERS DATED NONE AND ARE DISCUSSED IN THE PROJECT Massachusetts | New Hampshire | Virginia ENGINEERING REPORT AND/OR OTHER OFFICIAL PROJECT DOCUMENTS. **BID SET** TBD, AIRPORT MANAGER ADAM W. CUTLER, PE GALE ASSOCIATES, INC.

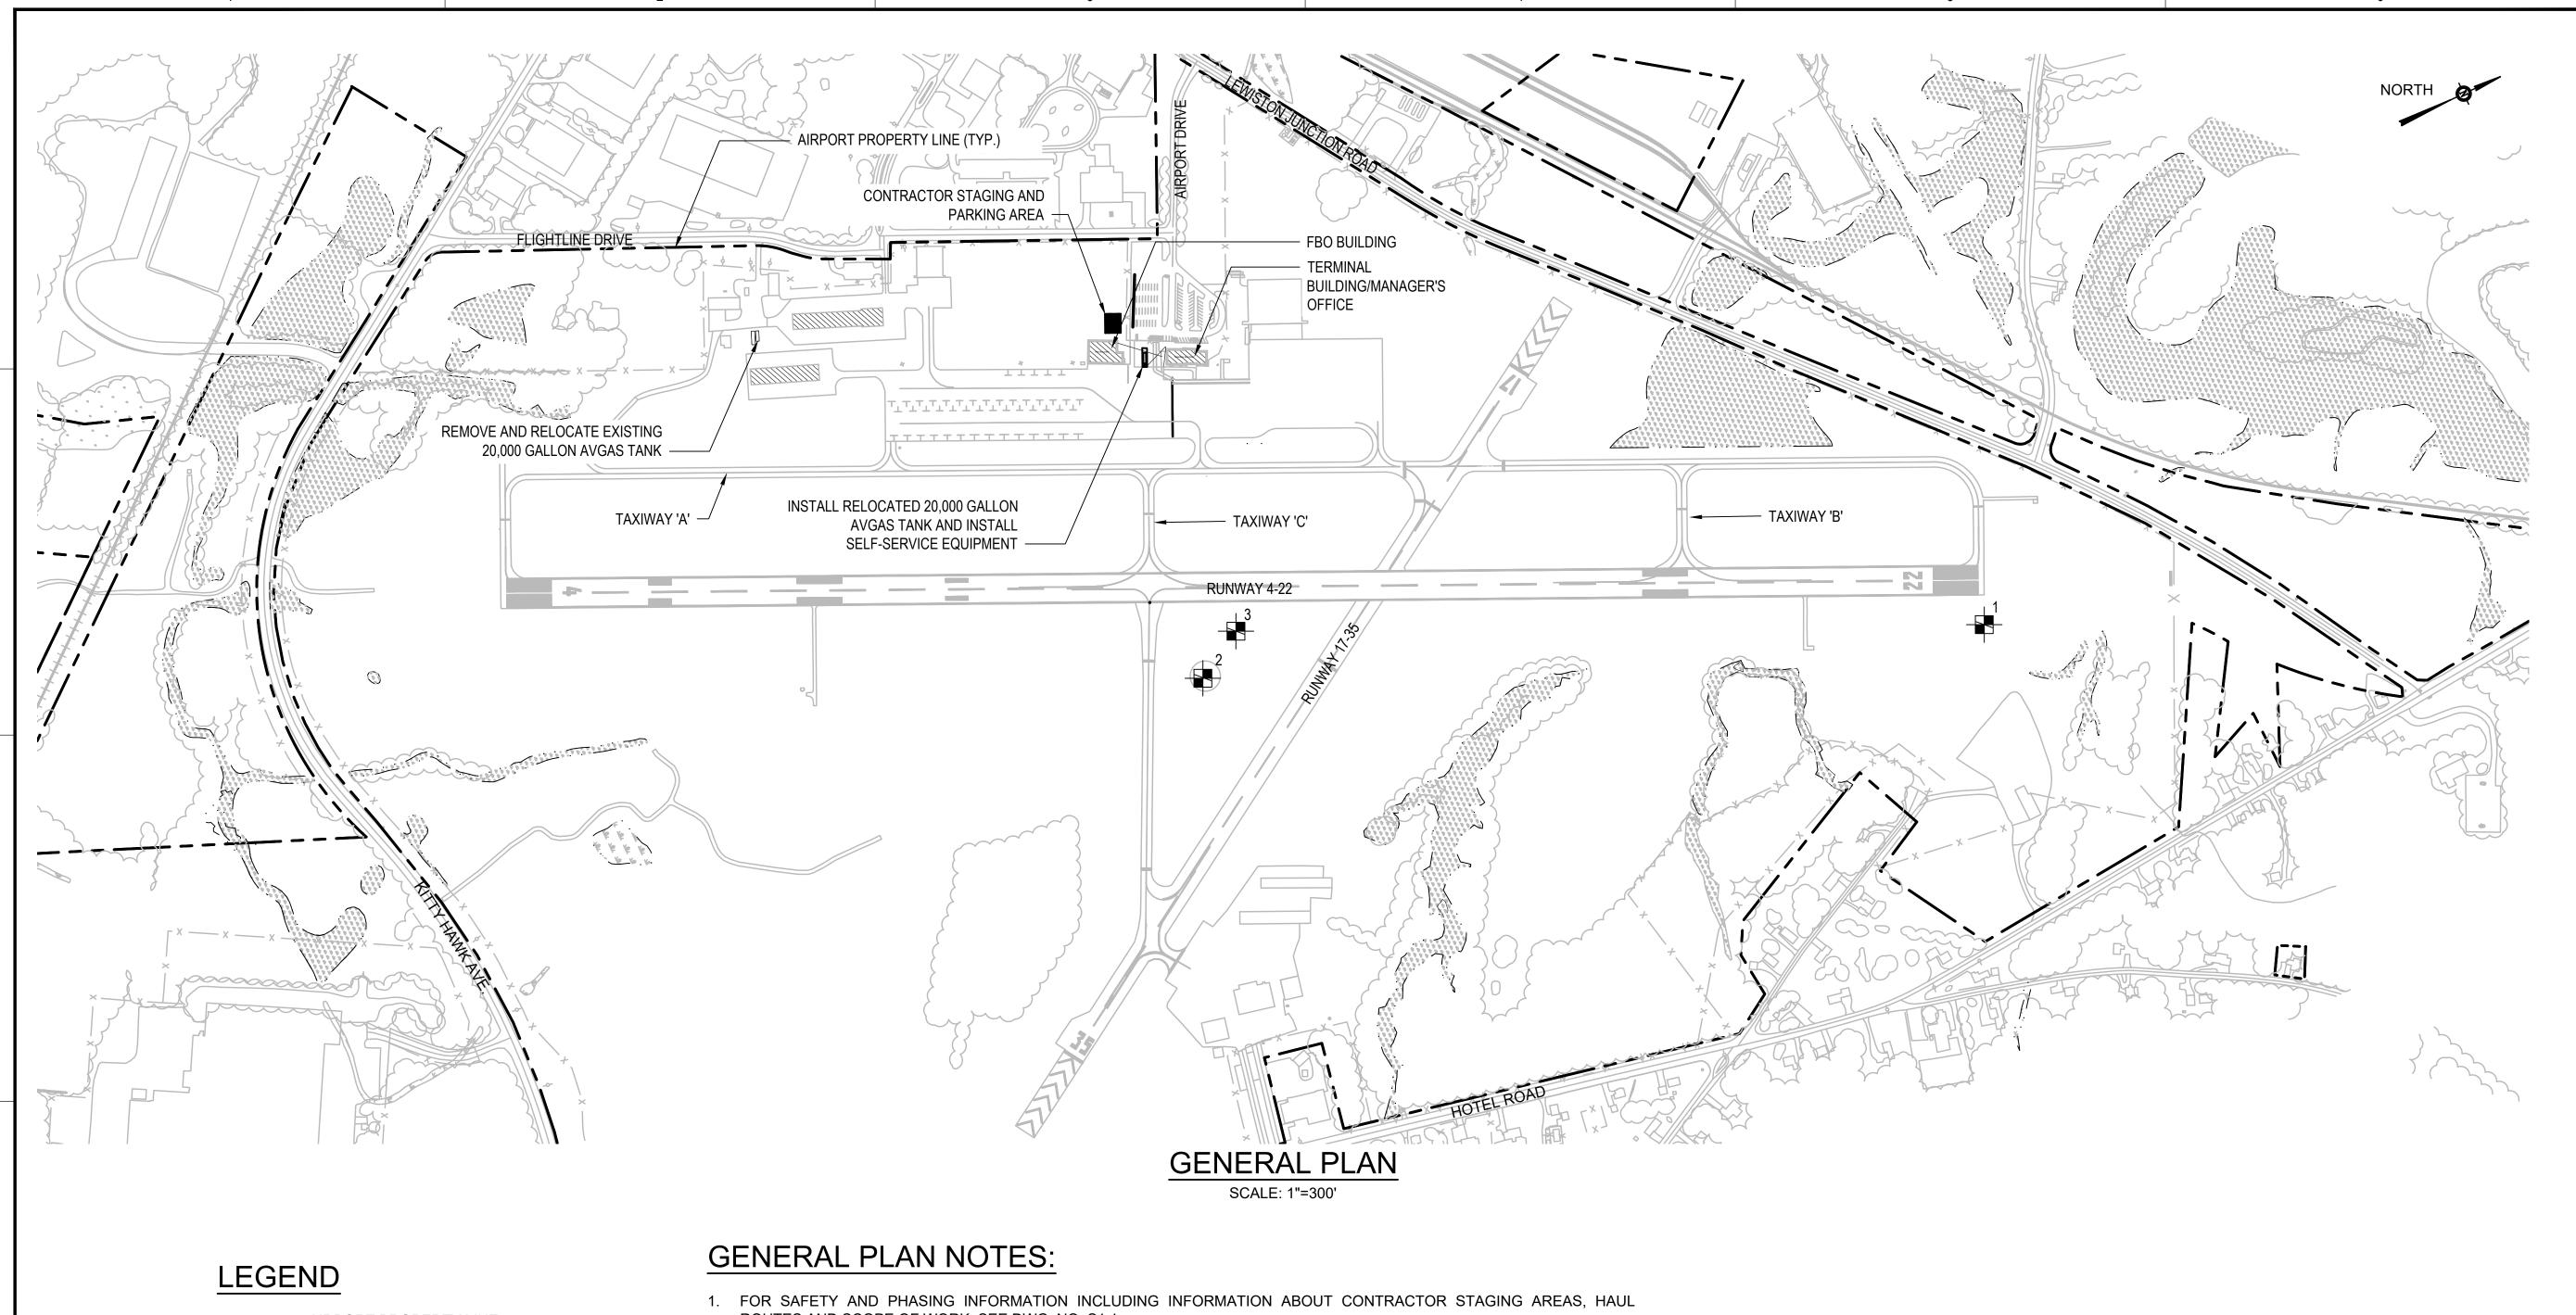

AIRPORT PROPERTY LINE

TREE LINE

EXISTING FENCE

EXISTING EDGE OF PAVEMENT

SURVEY MONUMENT

EXISTING WETLAND

- ROUTES AND SCOPE OF WORK, SEE DWG. NO. S1.1.
- 2. FOR SITE PLAN SEE DWG. NO. C1.1.

SURVEY CONTROL NOTES:

- 1. SURVEY CONTROL POINTS HAVE BEEN PROVIDED TO ASSIST THE CONTRACTOR IN ESTABLISHING HORIZONTAL AND VERTICAL CONTROL FOR THE LAYOUT OF WORK ON THIS PROJECT.
- 2. THE CONTRACTOR SHALL VERIFY AND MAINTAIN ALL SURVEY CONTROL POINTS DURING CONSTRUCTION. ALL WORK TO ENSURE SURVEY POINTS ARE MAINTAINED SHALL BE CONSIDERED INCIDENTAL TO THE OVERALL PROJECT.
- 3. PRIOR TO THE START OF CONSTRUCTION THE CONTRACTOR SHALL LOCATE AND CONFIRM THE DISTANCES AND ELEVATIONS OF THE CONTROL POINTS SHOWN IN THE SURVEY CONTROL TABLE. ANY DISCREPANCIES BETWEEN THE LISTED DATA AND THE CONTRACTORS MEASUREMENTS SHALL BE BROUGHT TO THE OWNER'S ATTENTION PRIOR TO THE START OF CONSTRUCTION.
- 4. IF ANY CONTROL POINTS ARE DISTURBED BY THE CONTRACTOR OR THEIR AGENTS THEY MUST BE REPAIRED PRIOR TO FINAL PAYMENT. POINTS SHALL BE INSTALLED TO THE SATISFACTION OF THE OWNER AND SHALL MEET ALL APPLICABLE NOAA STANDARDS FOR SURVEY CONTROL POINTS.
- 5. ELEVATIONS SHOWN ARE BASED ON THE NORTH AMERICAN VERTICAL DATUM OF 1988.

SURVEY CONTROL TABLE						
POINT NO.	POINT DESCRIPTION	LATITUDE	LONGITUDE	ELEVATION		
1	LEW AP STA B (SACS)	44° 03' 16.42" N	70° 16' 46.87" W	259.78'		
2	LEW D (PACS)	44° 02' 52.08" N	70° 16' 59.84" W	270.2'		
3	ARP RESET	44° 02' 53.72" N	70° 17' 01.14" W	269.2'		

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Gale Associates, Inc. Engineers and Planners

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BID SET

RELOCATE FUEL TANK AND INSTALL SELF-SERVICE EQUIPMENT	BID NUMBER: LA 2024-001	OWNER	AUBURN-LEWISTON AIRPORT CITY OF AUBURN, MAINE
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NO.	DATE	DESCRIPTION BY			
PRC	JECT NO.		777130		
CADD FILE			777130 - 02 -	G12	
DESIGNED BY			AWC		
DRAWN BY			AWC		
CHECKED BY		NAI			
DATE		JULY 2023			
DRAWING SCALE			1" = 300'		
GRAPHIC SCALE					

0	150	300	600		
SHEET TITLE					

GENERAL PLAN

DRAWING NO.

OF

WORK AREA NOTES:

- 1. ALL WORK BY THE CONTRACTOR SHALL BE DONE IN ACCORDANCE WITH THE MOST RECENT FAA ADVISORY CIRCULAR 150/5370-2G "OPERATIONAL SAFETY ON AIRPORTS DURING CONSTRUCTION".
- 2. LIGHTED BARRICADES WILL BE USED TO DESIGNATE ALL AREAS OF PAVEMENT WHICH ARE TO BE CLOSED DURING CONSTRUCTION ACTIVITIES. THE CONTRACTOR SHALL PROVIDE ALL BARRICADES TO BE USED ON THE PROJECT; THE CONTRACTOR MAY USE UP TO FIFTY (50) OF THE AIRPORT'S BARRICADES UPON REQUEST IF AVAILABLE. ANY OF THE AIRPORT'S BARRICADES DAMAGED OR DESTROYED DURING CONSTRUCTION SHALL BE REPLACED WITH THE CONTRACTOR'S BARRICADES AT THE END OF THE PROJECT. NO SEPARATE MEASUREMENT FOR PAYMENT WILL BE MADE FOR THE CONSTRUCTION BARRICADES, RATHER THEY SHALL BE CONSIDERED INCIDENTAL TO THE OVERALL PROJECT.
- 3. ALL EQUIPMENT, MATERIALS, AND LABOR TO ACCOMPLISH THE WORK AREA PHASING SHOWN ON THESE PLANS AND AS DESCRIBED HEREIN WILL NOT BE MEASURED SEPARATELY FOR PAYMENT, BUT RATHER SHALL BE CONSIDERED INCIDENTAL TO THE OVERALL PROJECT.
- 4. THE CONTRACTOR SHALL BE RESPONSIBLE FOR MEETING ALL APPLICABLE FAA, MAINEDOT, AND LOCAL REGULATIONS CONCERNING THE MAINTENANCE OF SECURITY. THIS SHALL INCLUDE, BUT NOT BE LIMITED TO THE CONTROL OF ACCESS TO THE AIRFIELD THROUGH THE PROJECT WORK AREAS AND HAUL ROUTES. THE CONTRACTOR IS RESPONSIBLE FOR ANY TEMPORARY FENCING, GATES, OR SECURITY PERSONNEL REQUIRED TO MEET THESE REQUIREMENTS.
- 5. NO WORK WILL BE PERMITTED TO BEGIN UNTIL ALL COMPONENTS OF THE SAFETY PLAN HAVE BEEN IMPLEMENTED TO THE SATISFACTION OF THE AIRPORT OPERATOR, ALL OF THE REQUIRED 7460'S HAVE BEEN FILED. AND NOTAMS HAVE BEEN ISSUED AND VERIFIED BY THE AIRPORT OPERATOR.

HAUL ROUTE NOTES:

D

- 1. ACCESS TO THE WORK AREA SHALL BE RESTRICTED TO THE THE DESIGNATED HAUL ROUTES SHOWN ON DWG. NO. S2.1. VEHICLES ARE CONFINED TO THE WORK AREA AND HAUL ROUTE ONLY.
- 2. THE CONTRACTOR IS PROHIBITED FROM CROSSING RUNWAYS, TAXIWAYS, OR APRONS WITH CONSTRUCTION EQUIPMENT WITHOUT PRIOR APPROVAL BY THE AIRPORT OPERATOR. AT APPROVED CROSSINGS THE CONTRACTOR WILL BE RESPONSIBLE FOR PROTECTING THE EXISTING PAVEMENT FROM DAMAGE. ALL PAVEMENT AREAS DAMAGED BY THE CONTRACTOR MUST BE REPAIRED TO FAA STANDARDS AND TO THE SATISFACTION OF THE OWNER AFTER ALL CONTRACT WORK HAS BEEN COMPLETED. NO MEASUREMENT FOR PAYMENT SHALL BE MADE FOR ANY REPAIRS TO EXISTING PAVEMENT SURFACES DAMAGED DURING CONSTRUCTION, RATHER THIS WORK SHALL BE PERFORMED AT THE CONTRACTOR'S EXPENSE.
- 3. THE HAULING OF MATERIALS FROM STAGING AREAS TO THE WORK AREAS MUST BE ON THE DESIGNATED HAUL ROUTES SHOWN ON THIS PLAN.
- 4. THE SPEED LIMIT ON HAUL ROADS AND PAVEMENT WITHIN AIRPORT PROPERTY SHALL BE FIFTEEN MILES PER HOUR (15 MPH). ON PUBLIC ROADWAYS, THE POSTED SPEED LIMITS SHALL BE OBEYED AT ALL TIMES.
- 5. THE CONTRACTOR MUST ALWAYS MAINTAIN AIRPORT SECURITY BY ENSURING THAT ALL GATES BEING USED FOR CONTRACTOR ACCESS REMAIN LOCKED OR MONITORED AT ALL TIMES.
- 6. AIRCRAFT ALWAYS HAVE THE RIGHT OF WAY.
- 7. STOP SIGNS (INCIDENTAL TO THE OVERALL PROJECT) MAY BE REQUIRED AT ANY LOCATION WHERE CONSTRUCTION VEHICLES CROSS ACTIVE AIRPORT PAVEMENTS. IF REQUIRED, THE LOCATION SHALL BE DETERMINED BY THE AIRPORT OPERATOR.
- 8. THE CONTRACTOR SHALL MAINTAIN CLEAN PAVED SURFACES, BOTH ON AND OFF AIRPORT PROPERTY DURING CONSTRUCTION OF THE PROJECT. THE AIRPORT OPERATOR RESERVES THE RIGHT TO REQUIRE THE CONTRACTOR TO IMMEDIATELY CLEAN ANY PAVED SURFACES ADVERSELY AFFECTED BY CONSTRUCTION ACTIVITIES.
- 9. THE CONTRACTOR'S STAGING AREAS, PARKING AREAS, AND HAUL ROADS TO/FROM THE WORK AREAS SHALL BE MAINTAINED FOR THE DURATION OF THE PROJECT IN A CLEAN AND STABLE CONDITION AND ANY DAMAGE RESULTING FROM CONSTRUCTION ACTIVITIES SHALL BE REPAIRED UPON COMPLETION OF THE PROJECT.



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BID SET

RELOCATE FUEL TANK AND INSTALL SELF-SERVICE EQUIPMENT BID NUMBER: LA 2024-001	OWNER	AUBURN-LEWISTON AIRPORT CITY OF AUBURN, MAINE
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NO.	DATE	D	BY	
PROJECT NO.		777130		
CADD FILE		777130 - 03 - S11		
DESIGNED BY		AWC		
DRAWN BY		AWC		
CHECKED BY		NAI		
DATE		JULY 2023		
DRAWING SCALE		NOT TO SCA	LE'	

GRAPHIC SCALE

SHEET TITLE

SAFETY AND PHASING NOTES

DRAWING NO.

52. I

4 OF

